PLAN 1

PLANNING APPLICATION P17-058 12 PATON STREET, LONGFORD

ATTACHMENTS

- A Application & plans
- B Response from referral agency
- C Representation
- D Planning report

ATTACHMENT B



Submission to Planning Authority Notice

Council Planning Permit No.	P17-058			Council notice date	14/03/2017	
TasWater details						
TasWater Reference No.	TWDA 2017/0033	7-NMC		Date of response	14/03/2017	
TasWater Contact	Anthony Cengia		Phone No.	(03) 6237 8243		
Response issued	to					
Council name	NORTHERN MIDLA	ANDS COUNCIL	- 1.00-1-100-100 and 100-100			
Contact details	Planning@nmc.ta	s.gov.au			9	
Development de	tails					
Address	12 PATON ST, LON	NGFORD Property ID (PID) 3358817			3358817	
Description of development	Multiple Dwelling	зs x 2				
Schedule of drav	vings/documents	Constitution of the Consti	that we have			
Prepa	ared by	Drawing/document No.		Revision No.	Date of Issue	
Kel Clark		08 N		March 2017		

Conditions

SUBMISSION TO PLANNING AUTHORITY NOTICE OF PLANNING APPLICATION REFERRAL

Pursuant to the Water and Sewerage Industry Act 2008 (TAS) Section 56P(1) TasWater imposes the following conditions on the permit for this application:

CONNECTIONS, METERING & BACKFLOW

- A suitably sized water supply with metered connections / sewerage system and connections to each dwelling unit must be designed and constructed to TasWater's satisfaction and be in accordance with any other conditions in this permit.
- 2. Any removal/supply and installation of water meters and/or the removal of redundant and/or installation of new and modified property service connections must be carried out by TasWater at the developer's cost.
- 3. Prior to commencing construction / use of the development, a boundary backflow prevention device and water meter must be installed, to the satisfaction of TasWater.

DEVELOPMENT ASSESSMENT FEES

- 4. The applicant or landowner as the case may be, must pay a development assessment fee to TasWater, as approved by the Economic Regulator and the fees will be indexed, until the date they are paid to TasWater, as follows:
 - a. \$201.93 for development assessment.

The payment is required within 30 days of the issue of an invoice by TasWater.



Advice

For information on TasWater development standards, please visit http://www.taswater.com.au/Development/Development-Standards

For application forms please visit http://www.taswater.com.au/Development/Forms

The developer is responsible for arranging to locate existing TasWater infrastructure and clearly showing it on any drawings. Existing TasWater infrastructure may be located by TasWater (call 136 992) on site at the developer's cost, alternatively a surveyor and/or a private contractor may be engaged at the developers cost to locate the infrastructure.

Declaration

The drawings/documents and conditions stated above constitute TasWater's Submission to Planning Authority Notice.

Authorised by

Jason Taylor

Development Assessment Manager


TasWater	Contact Details		
Phone	13 6992	Email	development@taswater.com.au
Mail	GPO Box 1393 Hobart TAS 7001	Web	www.taswater.com.au

HEGER CONSTRUCTIONS P/L LONGFORD UNIT 2, LOT 3 (16) PATON STREET UNIT DEVELOPMENT

PID 3358809 TITLE VOLUME - 172712 FOLIO - 3

DRAWING LIST

	TOTAL ADDITION OF	HITTO S.
	WET AREA SEALING HOTES	94 LEIK
1:100	PLUMBING PLAN	SHEET 9
1:200	SITE PLUMBING	SHEET 8
1:100	SETOUT PLAN	SHEET 7
8	CONSTRUCTION SECTION	STEET
1188	CHOSS SECTION	AFET :
1:100	ELEVATIONS	SHEET 4
1:100	FLOOR PLAN	HEET 3
1:400	SITE PLAN	SHEET 2
	SHELUCATION	1 111

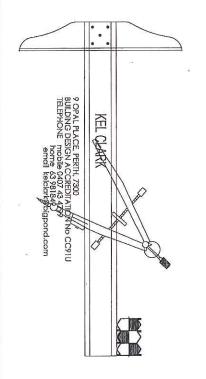

SHEET 20

PERSPECTIVE VIEWS

CH COMPLETE

SHEET 17

ENERGY/WINDOWS PLAN

1:100

STONE AND STONE

ROOF PLAN

を言めなられている

88

BUSHFIRE RISK ASSESSMENT = BAL LOW REFER TO REPORT No RGA-B347 (REBECCA GREEN & ASSOC)

DWELLING GARAGE DECK

117sm 22.1sm 17.5sm

LOT SIZE

367sm (approx site area unit 2)

AREA

REFER TO REPORT No TG16003/5 (TASMAN GEOTECHNICS) SITE CLASSIFICATION = H1


CLIMATE ZONE = 7

THERMAL PERFORMANCE = 6.0 STARS


REFER TO REPORT No TG16003/5 (TASMAN GEOTECHNICS)


DESIGN WIND SPEED = N2


IVIBINATTA

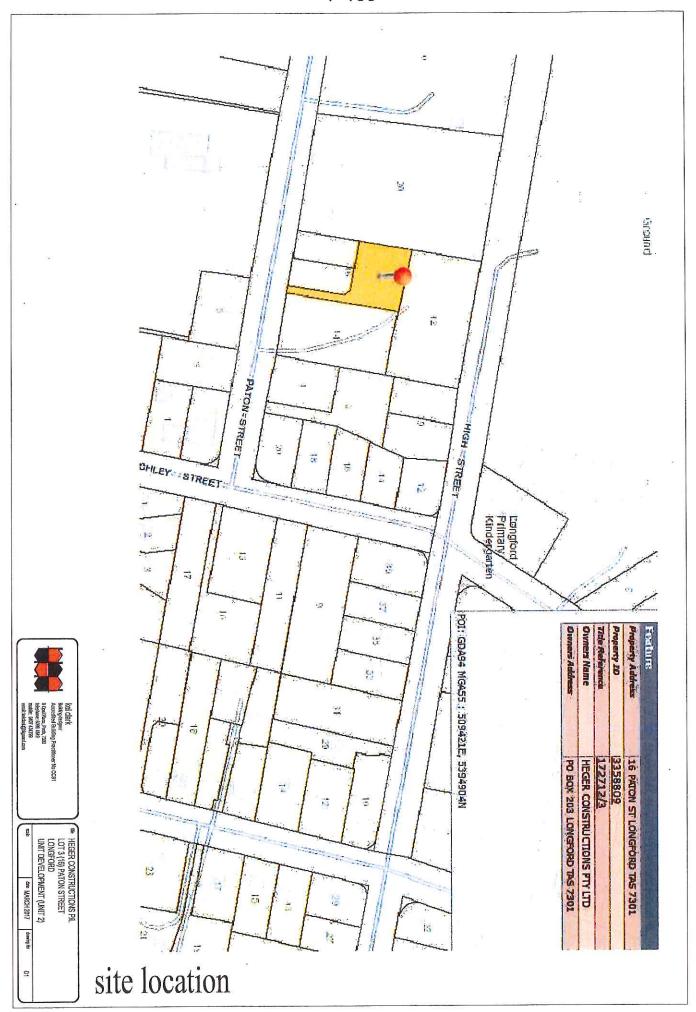




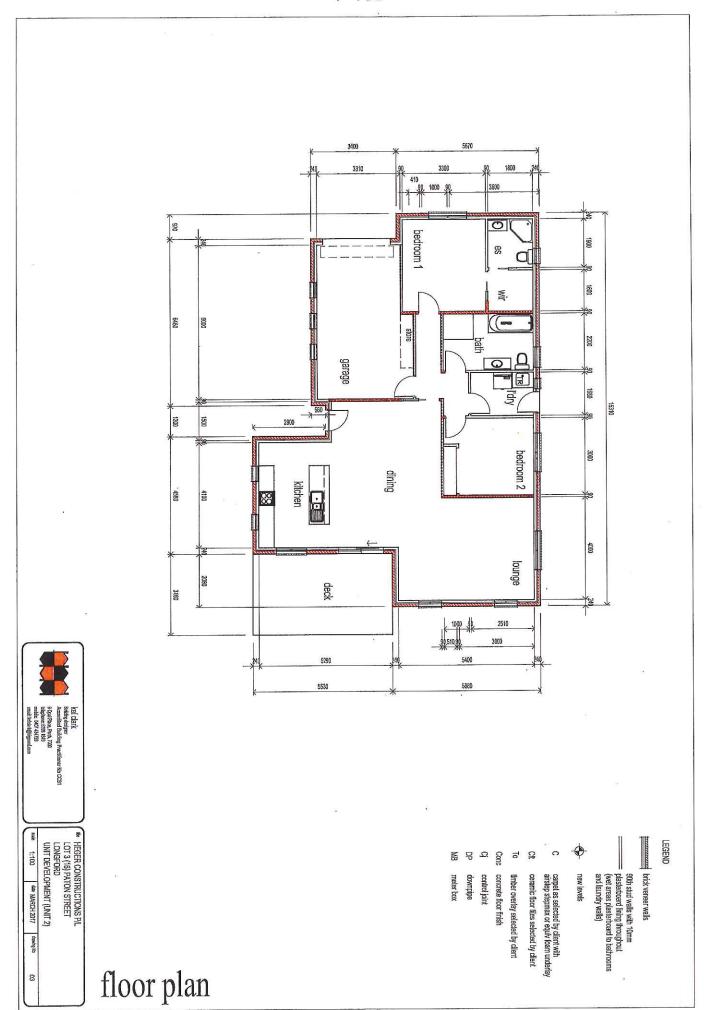


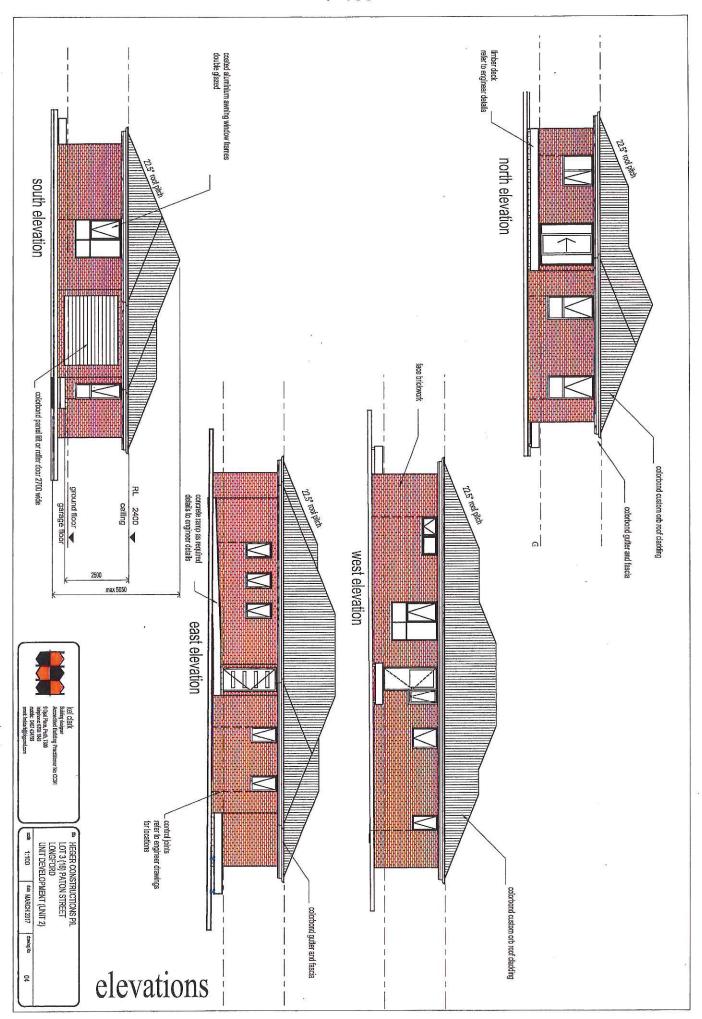


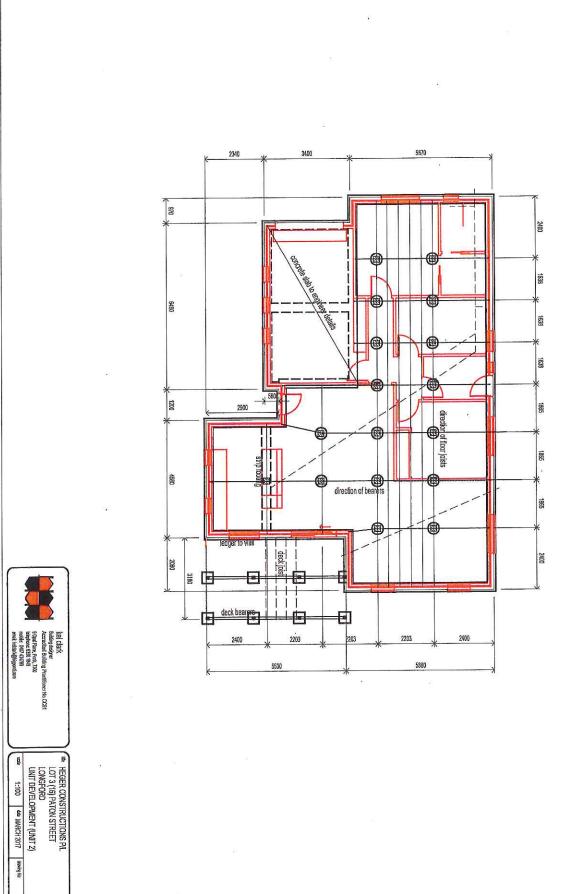

setout plan

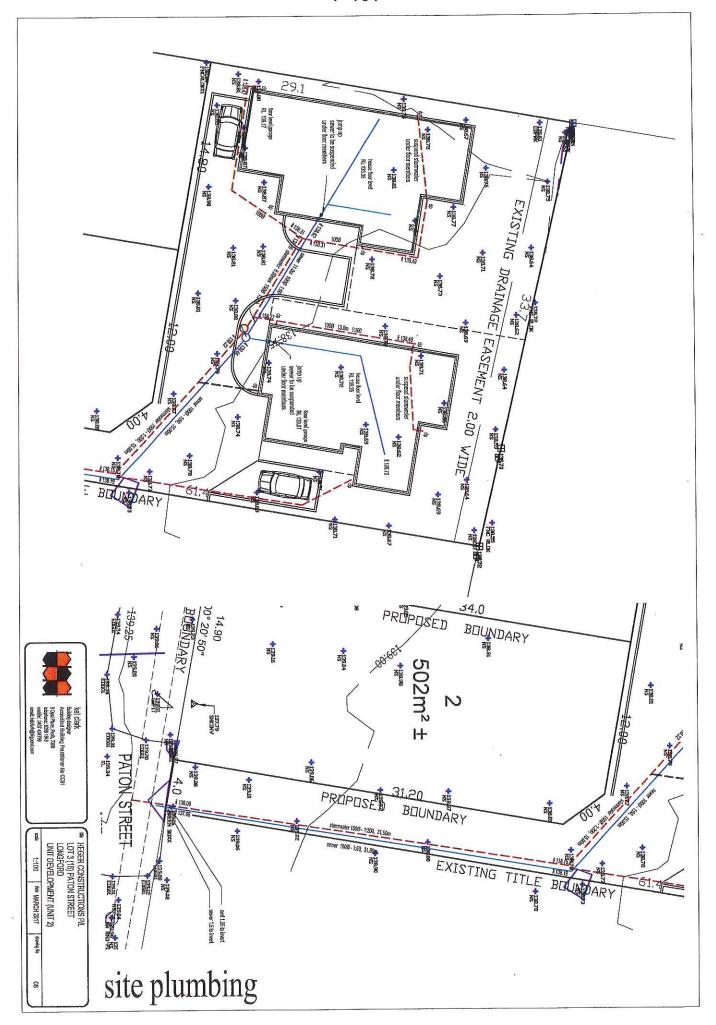

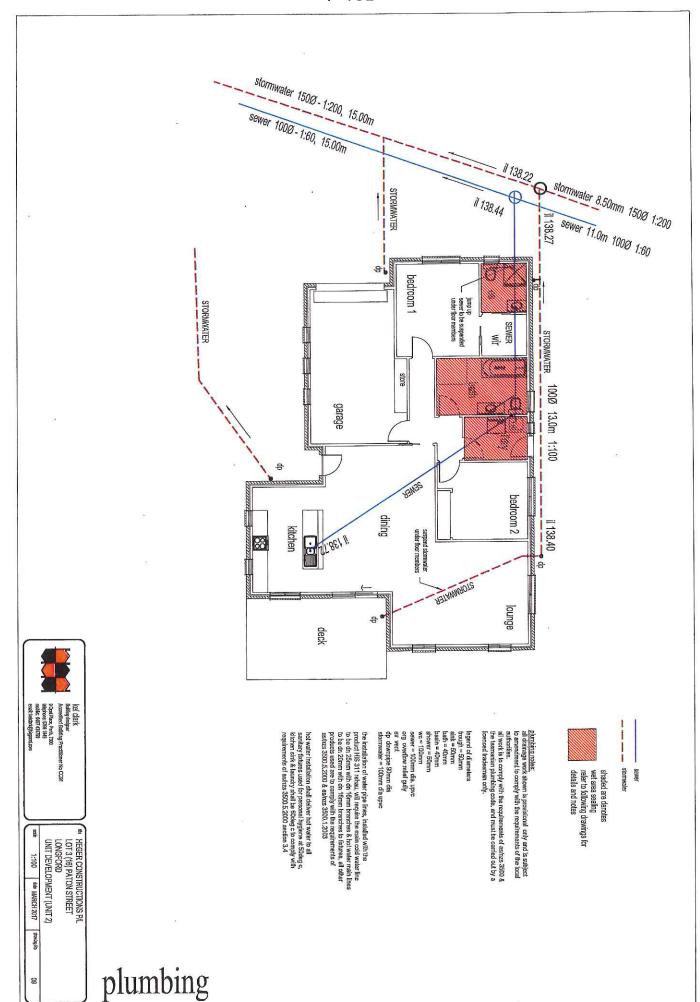

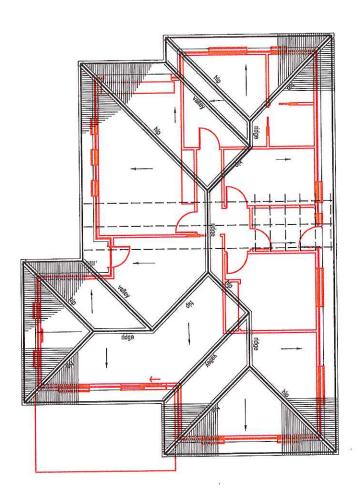



(ce) clarix
Badóng designur
Accredited filliding Practitioner No CCS1
9 Opal Plans, Park, 7300
belyanc ESS 1989
mode: 1001 43/178
emai: teledas@bjgord.com

LOT 3 (16) PATON STREET LONGFORD UNIT DEVELOPMENT (UNIT 2) 1:100 date MARCH 2017 drawing No

6

install selected colorbord qued guittes or as nonlineted by the owner, by guitters Topm in the decelsor of low, fine it is easily the an appropred siscone sealant. "Valley guittes to the 450 which colorbord seled for much not, the Strimm under mol cludding and turn up on both sides, lap 150 mm in direction of flow

medificating control and appropriate sheet rooting oxinchood colour to selection, over TS x 38 MGP12 oxincin not not seisal supproved and fuscose installed sticitly in accordance with manufactures recommendations. Its fuscos to trip plates with the j-type connectants, provide diagonal backing facility to publish as in any supplied 20°F to right, anchor storp brieding with 6 no 30x1,5 rails into double top plate, wind brazing to comply with NCC 2016


downpipes: downpipe is only prepinted to make guitaring, fiz with wall trackets @ downpipes to bed pre-painted to make guitaring, fiz with wall trackets @ 1200ca beginning at downpipe abow, martinum contest for guitars to be 1200c and located so as to comply with Part 3.5.2.5 of the BCA

colorbond preformed metal fascia and gutter installed in accordance with manufacturers instructions. colour to match the roof. fascia

coloured aluminium window frames awring winder sashes double glazing tes oak reveels and tims brick on edge external sils all fixings and flashing to manufacturers recommendations refer as 1288 & bca-2013

allow for preformed cappings & fashings necessary to ensure the integrity of the roof structure against water penetration, install flashings to roof rends, flues etc. alternatively use "delittle" or similar fittings to roof penetrations cappings & flashings:


roof plan

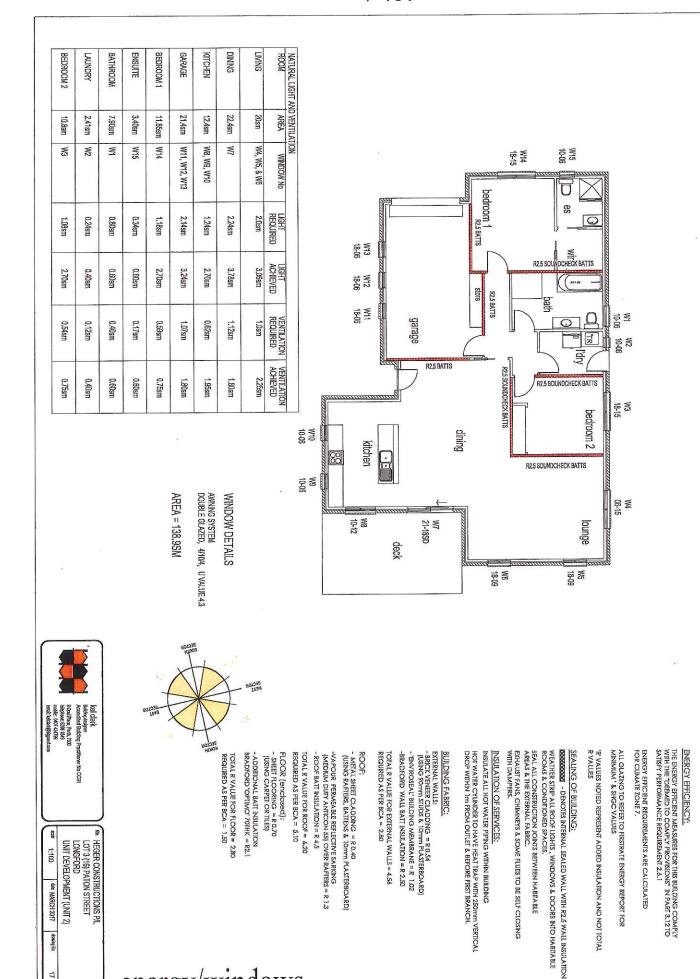


energy/windows


die MARCH 2017


drawing No

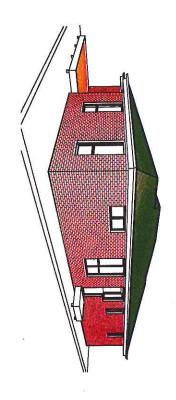

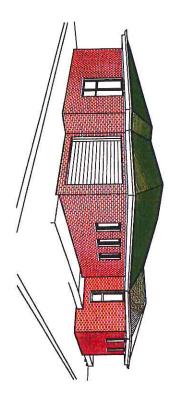

note
views are conceptual only
and not to be used for
construction purposes

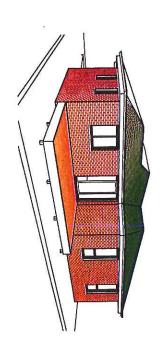

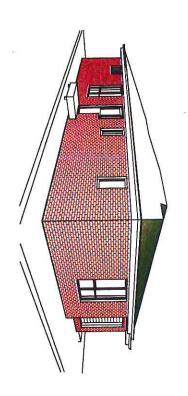

Rel Clark
Rading edger
According Practitioner to CC31
Accordin

Title HEGER CONSTRUCTIONS PILLOT 3 (16) PATON STREET LONGFORD UNIT DEVELOPMENT (UNIT 2)*

LONGFORD Gene IMARCH 2017 denting to

3D view

UNIT 1, LOT 3 (16) PATON STREET LONGFORD **HEGER CONSTRUCTIONS P/L** UNIT DEVELOPMENT

DWELLING GARAGE DECK

132sm 22sm 14.20sm

LOT SIZE

410sm (approx unit 1 site)

TITLE VOLUME - 172712 FOLIO - 3


DRAWING LIST

	SHEET 9	SHEET 8	SHEET, 7	学品	學用	SHEET 4	SHEET 3	SHEET 2	SHEET 1
SELECTED CENTING SELECTRICAL STATE SECURICAL STATE SECURICAL SETALS SECURICAL SETALS	PLUMBING PLAN WET AREA SEALING NOTES	SITE PLUMBING	SETOUT PLAN	NOTIONS WOLLDUNG SWC.	CROSS SECTION	ELEVATIONS	FLOOR PLAN	SITE PLAN	SITE LOCATION
18 8	1:100	1:200	1:100	07.4	COS	1:100	1:100	1:400	

REFER TO REPORT BY NRG EFFICIENT HOMES HERMAL PERFORMANCE = 6.0 STARS



BUSHFIRE RISK ASSESSMENT = BAL LOW

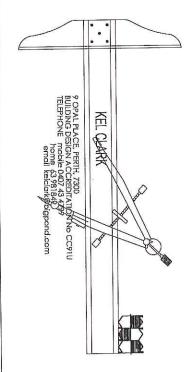


SHEET 1 SHEET 16


ENERGY/WINDOWS PLAN ROOF PLAN


1:100


CHING CHOUSE OR


PERSPECTIVE VIEWS

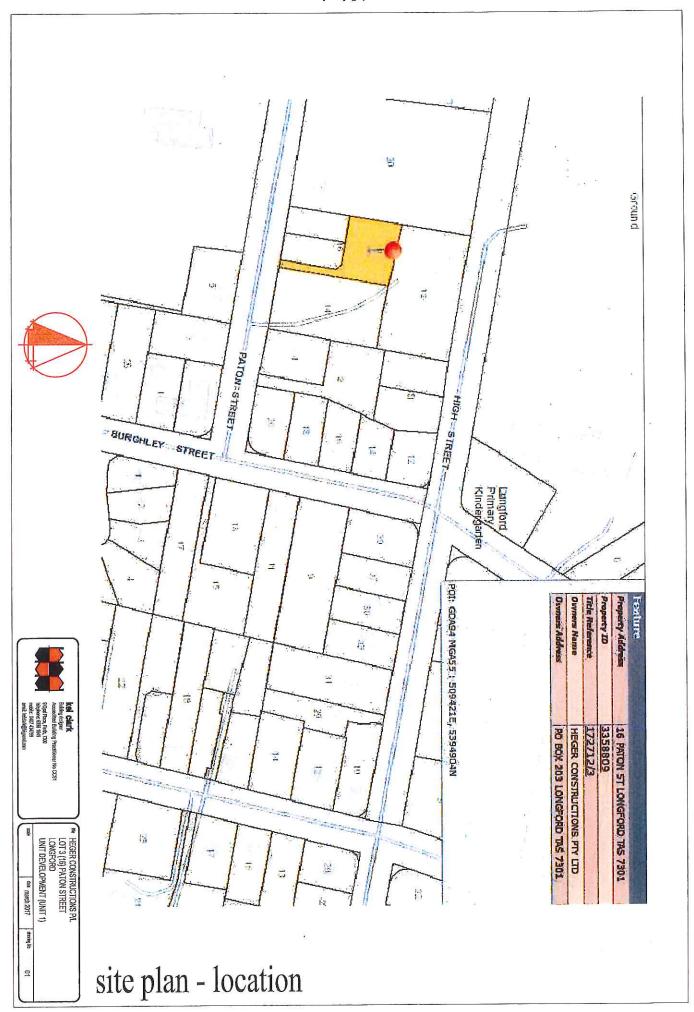


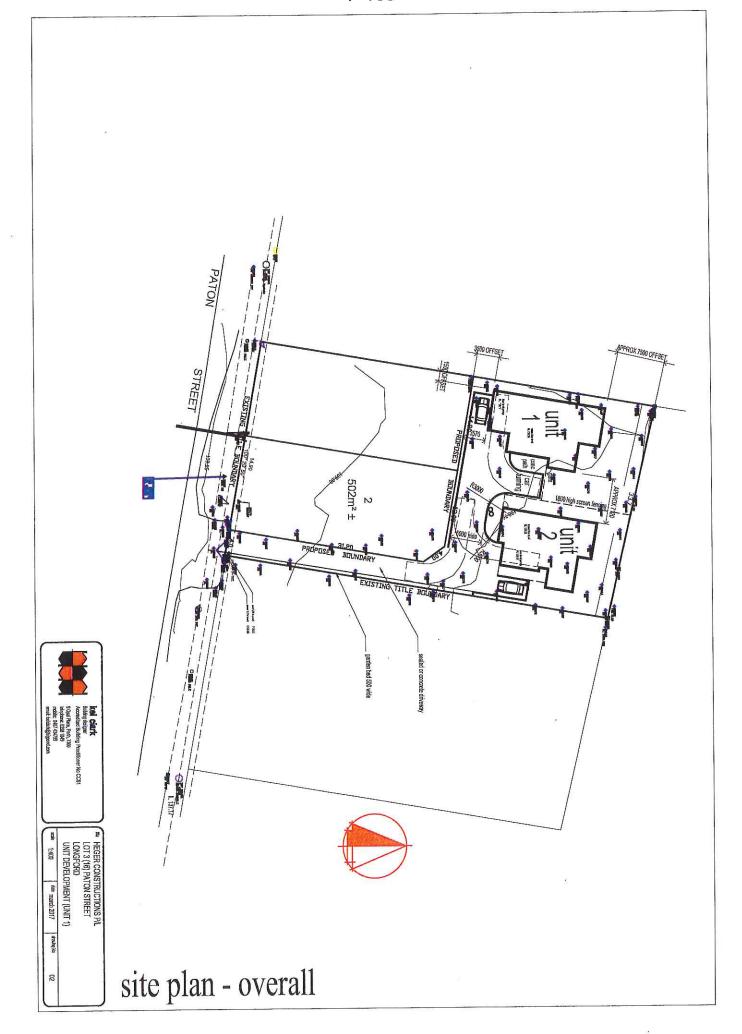


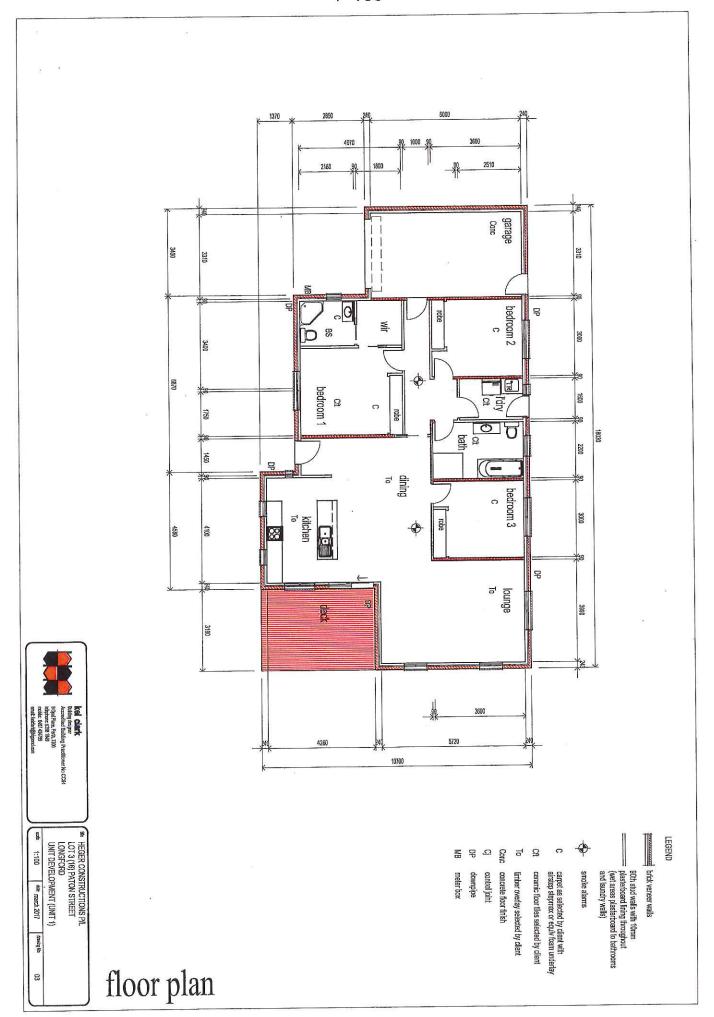

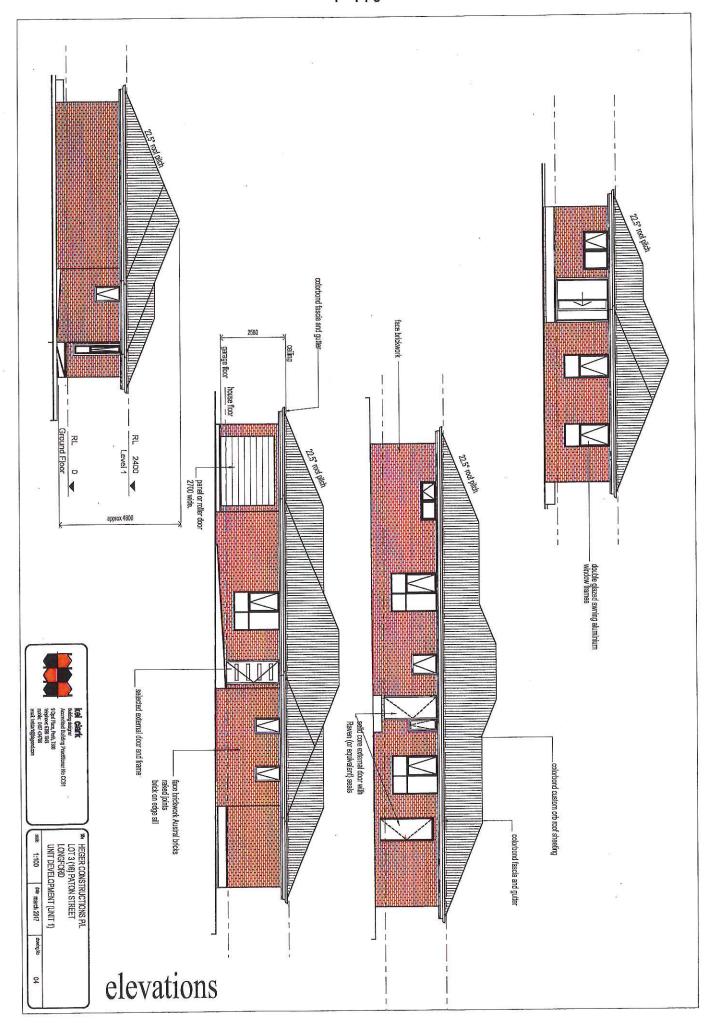

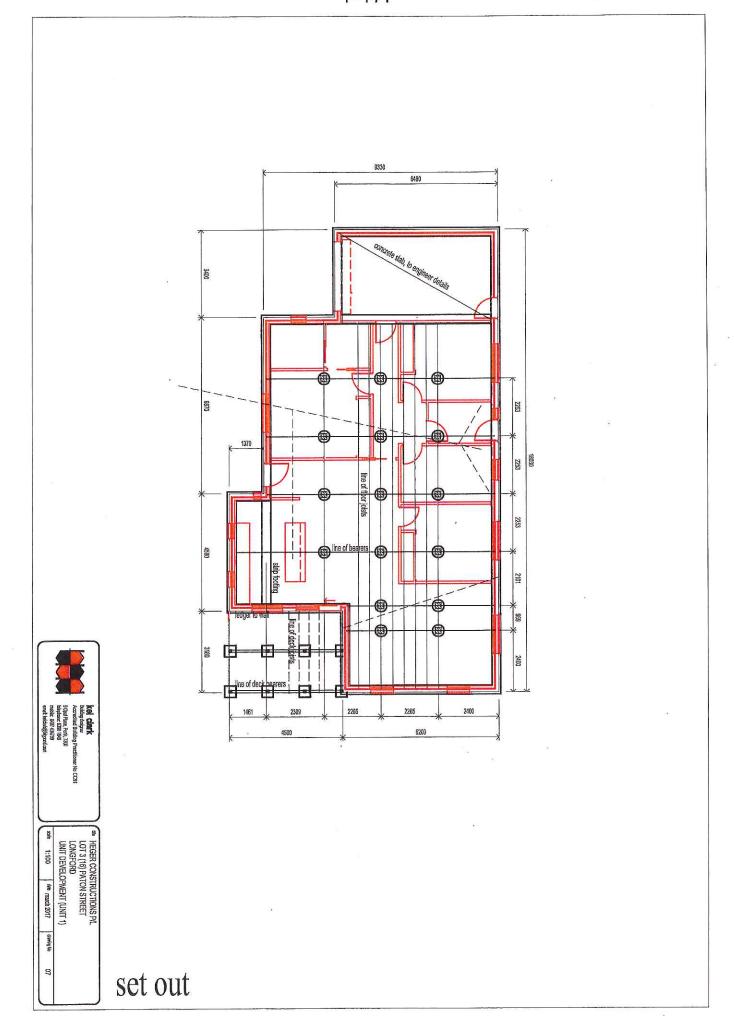

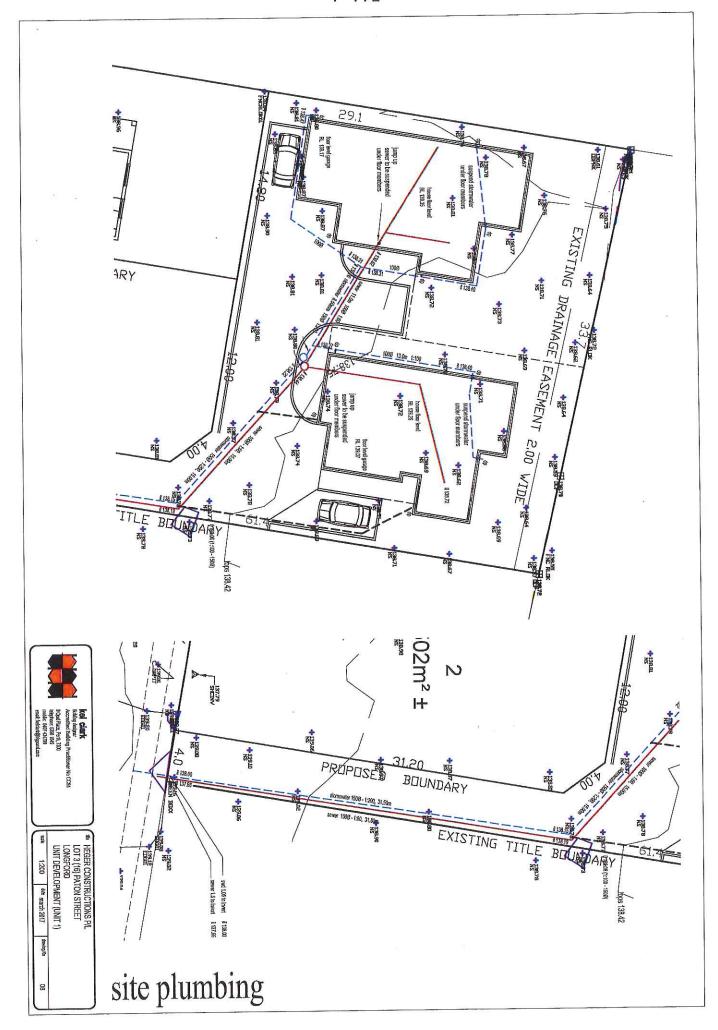

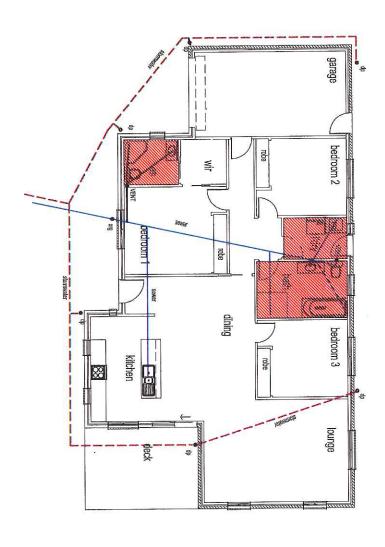



plumbing notes:
all drainage work shown is provisional only and is subject
to amendment to comply with the requirements of the local all work is to comply with the requirements of as/nzs 3500 & the tasmanian plumbing code, and must be carried out by a

icenced tradesman only.

legend of diameters frough = 50mm sink = 50mm sink = 50mm bath = 40mm shower = 50mm wer = 100mm dia upwo org overflow relad gubly ev vent od ownploe 50mm dia upwo do ownploe 50mm dia upwo stormwelter = 100mm dia upwo stormwelter = 100mm dia upwo


the installation of water pipe lines, installed with the product HIS 311 rehau. Will trequire the main cold water line to be dru 25mm with 10 filom instructions & hot water waiting to be drug 25mm, with 10 filom instructions to focuses, all other products used are to comply with the majuroments of early 3500.5,2000 & askinzs 3500.1,2003

hot water installation shall deliver hot water to all samilary fixtures used for personal hygiene at 50deg c, kilchen sink & laundry shall be 60deg c to comply with requirements of as/hzs 3500.5.2000 section 3.4

kol clark Badiogdolgraf Accordinal Bulding Pracibiosov No CCS1 SOyal Pina, Peth, 730 Johanne CSS 198 mohle NOV 45179 ema't kaldurghtgrand.om

MEGER CONSTRUCTIONS PAL LOT 3 (16) PATON STREET LONGFORD UNIT DEVELOPMENT (UNIT 1) 1:100 date march 2017 8

plumbing

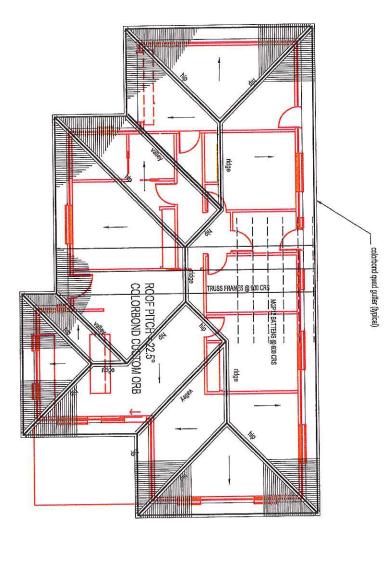

not framing not or saids approved sheet rooking adobtoed adour to sebedian over 70 x 56 MGP12 assistan dut or saids approved about treasus installed study in accordance with manufadures recommendations. As trusses to trap plates with traje-gly connectors, princible diagonal beach grant of by about sits a narrangel of 30° to floyer, authors step bracing with 6 no 30x1,5 rails into double top plate, wind bracing to comply with NCC - 2016

dOwnpipes:
downpipes to downpipe printed to makin guittering, fix with wall brackets @
1200ce beginning at downpipe abow, maximum couless for guitters to be
1200c and located so as to comply with Part 3.5.2.5 of the BCA

colorbond preformed metal fascia and gutler installed in accordance with manufacturers instructions. exlour to match the roof.

coloured aluminium window frames awning winder sashes double glazing las celk reveals and times brick on edge external sills all fixings and flashing to manufacturers recommendations reter as 1288 & NCC-2016

alizm for selected colourbond customs oft sheeting over 75x58 F14 five punits: at 900 cost & statellion, lap at side 1,5 corrugations and turn up at high point, fix with matching self drilling screws with neoprene wasters

install selected colorboard quad guitters or as nonlimeted by the owner, pay guitters. Thom in the interchanol flow, frent & seal with an approxed silicone scalarab.

Thom is the distributed colorboard select in metal hord, last 45 Stimm under tool feed by the 45 Stimm under tool feeding and furn up on both sides. Bip 150mm in direction of flow cappings & flashings:

cappings & flashings:


cappings & flashings necessary to ensure the integrity of the not show for preference applied water precipion, restall flashings to not vesus, flass etc.


alternatively use "debtile" or similar fillings to not peretirations

kel Clark Babing deriger Armedied Bilding Practioner No CCS1 9 Opal Run, Proft, 7309 Elegion: ESS 198 Iroda: 1014 43139 erati: bildin@jigmod.om

I				l
16	drawing No	date march 2017	scale 1:100	ST.
		JNIT DEVELOPMENT (UNIT 1)	JULI DEVE	_
		_	LONGFORD	_
		LOT 3 (16) PATON STREET	DT 3 (16) F	_
		HEGER CONSTRUCTIONS PAL	HEGER CO	# T

roof plan

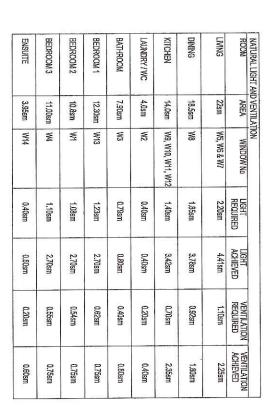

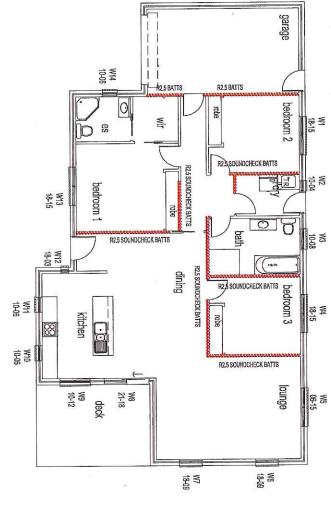



AWNING SYSTEM DOUBLE GLAZED, 4/10/4, U VALUE 4.3

WINDOW DETAILS



FLOOR (enclosed):

SHEET FLOORING = R 0.70 [USING CARPET OR TILES]

BRADFORD 'OPTIMO' 70THK = R2.1

TOTAL:R VALUE FOR FLOOR = 2.80 REQUIRED AS PER BCA = 1.50

ENERGY EFFICIENCY:

THE ENERGY EFFICIENT MEASURES FOR THIS BUILDING COMPLY WITH THE "DEEMED TO COMPLY PROVISIONS" IN PART 3.12 TO SATISFY PERFORMANCE REQUIREMENT 2.6.1

ENERGY EFFICIENT REQUIREMENTS ARE CALCULATED FOR CLIMATE ZONE 7.

ALL GLAZING TO REFER TO FIRSTRATE ENERGY REPORT FOR MINIMUM' & SHGC VALUES

'R' VALUES NOTED REPRESENT ADDED INSULATION AND NOT TOTAL R VALUES

- DENOTES SEALED WALL WITH R2.0 WALL INSULATION SEALING OF BUILDING:

SEAL ALL CONSTRUCTION JOINTS BETWEEN HABITABLE AREAS & THE EXTERNAL FABRIC. WEATHER STRIP ALL ROOF LIGHTS , WINDOWS & DOORS INTO HABITABLE ROOMS & CONDITIONED SPACES. EXHAUST FANS, CHIMNEYS & SOME FLUES TO BE SELF CLOSING WITH DAMPERS.

NSULATION OF SERVICES:

HOT WATER CYLINDER TO HAVE HEAT TRAP WITH 250mm VERTICAL DROP WITHIN 1m FROM OUTLET & BEFORE FIRST BRANCH. INSULATE ALL HOT WATER PIPING WITHIN BUILDING

BUILDING FABRIC:


EXTERNAL WALLS:
- BRICK VENEER CLADDING = R 0.54
[USING 90mm STUDS & 10mm PLASTERBOARD] TOTAL R VALUE FOR EXTERNAL WALLS = 4.56
REQUIRED AS PER BCA = 2.80 - "ENVIROSEAL" BUILDING MEMBRANE = R 1.02 -BRADFORD WALL BATT INSULATION = R 2.50

REQUIRED AS PER BCA = 5,10 TOTAL R VALUE FOR ROOF = 6.20 - ROOF BATT INSULATION = R 4.5 VAPOUR PERMEABLE REFLECTIVE SARKING
(MEDIUM DUTY ANTICON 55) OVER RAFTERS = R 1.3 - METAL SHEET CLADDING = R 0.40 (USING RAFTERS, BATTENS & 10mm PLASTERBOARD)

Kel clark
Buking destrer
Accredited Building Pract
9 Opal Place, Perth, 7300
Melphane: 6598 1649 Joner No CC91

HEGER CONSTRUCTIONS PA LOT 3 (16) PATON STREET LONGFORD UNIT DEVELOPMENT (UNIT 1) 1:100 date march 2017

energy/windows

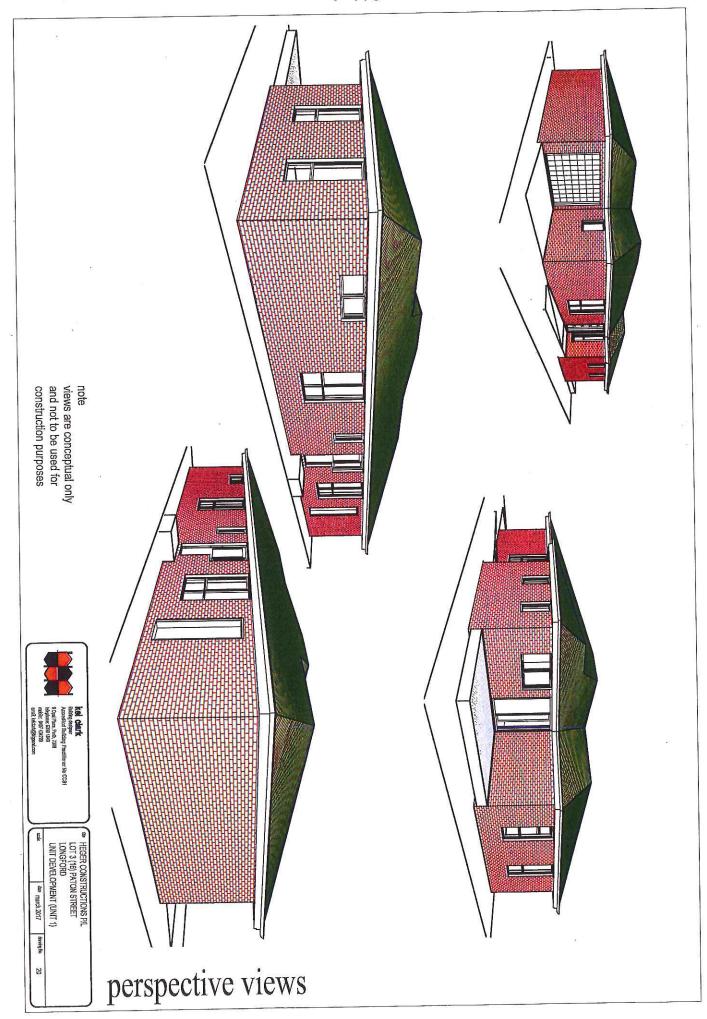

Site Specific Study for P17 - .053

Lot 3/16 Paton Street, Longford

2 new dwelling units

Response to planning scheme provisions of Code E11- Environmental Impacts and Attenuation Code, Clause E11.6.1 (P1):

- P1 Sensitive use or subdivision for sensitive use within an attenuation area to an existing activity listed in Tables E11.1 and E11.2 must demonstrate by means of a site specific study that there will not be an environmental nuisance or environmental harm, having regard to the:
 - a) degree of encroachment; and

The proposed development is 1018 meters from the abattoir. The space between is predominately made up of residential housing.

- b) nature of the emitting operation being protected by the attenuation area; and

 The operation is an abattoir which emits noise and odours, neither of which are prevalent at the site.
- c) degree of hazard or pollution that may emanate from the emitting operation; and
 The emission produced don't have any negative effects on the site
 - d) the measures within the proposal to mitigate impacts of the emitting activity to the sensitive use.

The distance of the proposed development from the emitting site as earlier stated is 1018 meters which is right on the edge of the attenuation area which is listed in the scheme as 1000 meters. Due to the fact the majority of this area is residential housing we don't believe any measures are required to mitigate against emissions.

Jamie Heger Heger Constructions pty ltd



FOLIO PLAN-178

RECORDER OF TITLES






Registered Number PLAN OF SURVEY HEGER CONSTRUCTIONS PTY. LTD. OWNER SP172712 R. M. PECK BY SURVEYOR FOLIO REFERENCE C.T.169293/4-2 LOCATION TOWN OF LONGFORD PART OF LOT 2, 1 A 2 R 27 P GRANTED TO JOHN REID (SEC. C1) flice LENGTHS IN METRES Recorder of Titles SCALE 1:250 ALL EXISTING SURVEY NUMBERS TO BE CROSS REFERENCED ON THIS PLAN LAST PLAN No. MAPSHEET MUNICIPAL CODE No 123 (5039-33) LAST UPI No LOT 3 COMPILED FROM CT169293/2 AND THIS SURVEY (P138736) HIGH STREET (SP169293) DRAINAGE EASEMENT 'B' 2.00 WIDE (SP169293) (6) CESTANAGE 2:00 WIDE (CESTANAGE) ること 3 29. 3 (SP169293) 1095m² 2 61.46 PATON STREET 100° ENLARGEMENT 21 14.80 SCALE 1: 1000 00" 12.00 (D15547) 1 2 503m² 9° 45' 00" (SP169293) 503m² (1) 45'00" 15,00" 14.80 100° 21' 00° 14.90 100° 21' 00° 4.03 PATON STREET 6-2-2017 COUNCIL DELEGATE



RESULT OF SEARCH

RECORDER OF TITLES

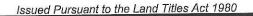



SEARCH OF TORRENS TITLE

VOLUME	FOLIO
172712	3
EDITION	DATE OF ISSUE
1	10-Feb-2017

SEARCH DATE : 01-Mar-2017 SEARCH TIME : 09.18 AM

DESCRIPTION OF LAND

Town of LONGFORD
Lot 3 on Sealed Plan 172712
Derivation: Part of Lot 2, 1A-2R-27P Gtd. to John Reid
Prior CT 169293/2

SCHEDULE 1

M544409 TRANSFER to HEGER CONSTRUCTIONS PTY LTD Registered 26-Nov-2015 at 12.01 PM

SCHEDULE 2

Reservations and conditions in the Crown Grant if any SP172712 EASEMENTS in Schedule of Easements SP172712 FENCING COVENANT in Schedule of Easements SP169293 FENCING COVENANT in Schedule of Easements D49277 AGREEMENT pursuant to Section 71 of the Land Use Planning and Approvals Act 1993 Registered 03-Apr-2012 at noon MORTGAGE to Bendigo and Adelaide Bank Limited Registered 26-Nov-2015 at 12.02 PM


UNREGISTERED DEALINGS AND NOTATIONS

No unregistered dealings or other notations



SCHEDULE OF BEASEMENTS

RECORDER OF TITLES

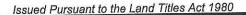



SCHEDULE OF EASEMENTS

NOTE: THE SCHEDULE MUST BE SIGNED BY THE OWNERS & MORTGAGEES OF THE LAND AFFECTED.

SIGNATURES MUST BE ATTESTED.

Registered Number

SP 1172712

PAGE 1 OF 2 PAGES

EASEMENTS AND PROFITS:-

Each lot on the plan is together with:-

- (1) Such rights of drainage over the drainage easements shown on the plan (if any) as may be necessary to drain the stormwater and other surplus water from such lot; and
- (2) Any easements or profits a prendre described hereunder.

Each lot on the plan is subject to:-

- (1) Such rights of drainage over the drainage easements shown on the plan (if any) as passing through such lot as may be necessary to drain the stormwater and other surplus water from any other lot on the plan; and
- (2) Any easements or profits a prendre described hereunder.

 The direction of the flow of water through the drainage easements shown on the plan is indicated by arrows.

No profits a prendre are created to benefit or burden the lots shown on the plan,

Lot 3 on the Plan is subject to a Right of Drainage (appurtenant to Lots 1 & 6 on Sealed Plan 169293) over the area marked "Drainage Easement B" 2.00 wide (SP 169293) as shown passing through Lot 3 on the Plan.

Lot 3 on the Plan is together with a Right of Drainage over the area marked "Drainage Easement C" 2.00 wide as shown passing through Lot 6 on Sealed Plan 169293 on the Plan.

FENCING COVENANT:-

The owner of each Lot on the Plan covenants with the Vendor (Heger Constructions Pty Ltd) that the Vendor shall not be required to fence.

SUBDIVIDER: Heger Constructions Pty Ltd CERTIFICATE OF TITLE VOLUME 169293 FOLIO 2

SOLICITOR & REFERENCE: P L Corby & Co (C J Foon) PLAN SEALED BY: Northern Midlands Council

DATE: 6.2.2017 P16-041-01

27/003/747....

F NO. Council Delegate


NOTE: The Council Delegate must sign the Certificate for the purposes of identification.

Page 1 of 2



SCHEDULE OF EASEMENTS

RECORDER OF TITLES

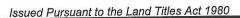



ANNEXURE TO SCHEDULE OF EASEMENTS

Registered Number

PAGE 2 OF 2 PAGES

SP 1172712

SUBDIVIDER:

FOLIO REFERENCE:

Heger Constructions Pty Ltd Volume 169293 Folio 2

EXECUTED by HEGER CONSTRUCTIONS)
PTY LTD (ACN 118 384 160) by being signed)
by its Directors KERRY CHARLES HEGER)
and JAMIE CHARLES HEGER pursuant to)
Section 127 of the Corporations Law)

AM

NOTE: Every annexed page must be signed by the parties to the dealing or where the party is a corporate body be signed by the persons who have attested the affixing of the seal of that body to the dealing.

PLANNING APPLICATION

Proposal

Description of proposal: 2 dwelling wils.
(attach additional sheets if necessary)
Site address: Lot 3 16 Paton Street
Longford.
CT no:
Estimated cost of project \$36000 (include cost of landscaping, car parks etc for commercial/industrial uses)
Are there any existing buildings on this property? Yes / No If yes – main building is used as
If variation to Planning Scheme provisions requested, justification to be provided:
unit I setbach to southern boundary. to
provide more open spopue la north
(attach additional sheets if necessary)
Is any signage required?

PLANNING APPLICATION

Applicant / owner details

Applicant: Head Constructions Py (tol' Signature of Applicant:
Signature of Applicant: Applicant's Details: 10 Box Postal address: 203 Longford Tas
Phone: 049 345 978
E-mail: heger Constructions @ bigpond. com.
Name of Owner/s of subject site: Head Coastruct or fly flow (as per certificate of title) (If the subject site is Crown land, owned by the Council or administered by the Council or the Crown, the application must be signed by either the responsible Minister of the Crown (or the Minister's delegate) or by the General Manager of the Council, and must be accompanied by written permission of that Minister or general manger to the making of the application.)
Owner's postal address: QS above.
Owner's email address: as about
As the owner of the land, I consent to the application being submitted, Signed: OR As the applicant, I declare that I have notified the owner of the application
Signed:
Right of Way: If the subject site is accessed via a right of way, the owner of the ROW must also be notified of the application.
Name of Owner/s of ROW:
ROW Owner's Postal Address:
Signed:
Office use only: Paid \$ 1066 Date: 27/2/17 Receipt No: 38/576 (Code 01)
Ref: P1 / Discretionary / Permitted / No Permit Required