PLAN 3

PLANNING APPLICATION PLN-19-0154 97 WELLINGTON STREET, LONGFORD

ATTACHMENTS

- A Application & plans
- B Responses from referral agencies
- C Representations & applicant's response

ATTACHMENT A




PLN-19-0154

AERIAL PHOTOGRAPH & SERVICES MAP for 97 WELLINGTON STREET, LONGFORD

ZONING MAP - GENERAL RESIDENTIAL ZONE



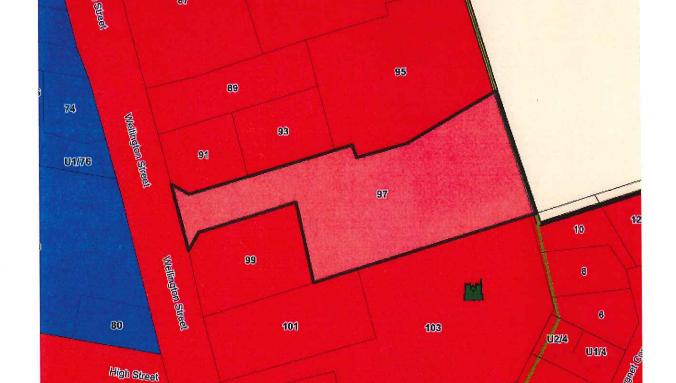

1-473 PLANNING APPLICATION

Proposal



Description of proposal:N	IEW GARAGE/SHED	
<u> </u>		
(attach additional sheets if necessary)		
Site address: 97 WELLINGTON	I STREET, LONGFOR	D TAS
CT no: 122410/3		
Estimated cost of project	\$60,000	(include cost of landscaping, car parks etc for commercial/industrial uses)
Are there any existing buildings If yes – main building is used as		HOUSE UNDER CONSTRUCTION
If variation to Planning Scheme	provisions requeste	ed, justification to be provided:
RESIDENCE WHICH IS APPROX 1 BOUNDARY TO AVOID IMPACTI	L6M AWY. THE SHE NG.ON.THE NEIGHE	Y WILL NOT OVERSHADOW THE NEIGHBOURING D HAS BEEN SITED TOWARDS THE SOUTHERN SOURING RESIDENCE. THERE IS AN EXISTING FENCE ALREADY PROVIDES PRIVACY TO THE DWELLING
(attach additional sheets if necessary)		
		9 N
Is any signage required? NO.		(if yes, provide details)

WNER Robert Mockinnon Horrison. Frank Cottier Borid, Violat May Barnas. DLIO REFERENCE

2.T 31552-1, C.T. 33775-1, C.T. 33775-6.

art of 63 43 50° Gtd. to William 10500.

PLAN OF SURVEY

BY SURVEYOR M.R ROSE - G. J. WALKEM & CO. P/L LAUNCESTON.

LOCATION

TOWN OF LONGFORD.

SCALE 1:750.

LENGTHS IN METRES


REGISTERED NUMBER

SP122410

APPROVED FROM 2.7 MAY 1996.

APSHEET MUNICIPAL LAST PLAN No.D.34552, SP33775 LAST UPI No. 5602553

ALL EXISTING SURVEY NUMBERS TO BE CROSS REFERENCED ON THIS PLAN)DE No. -/23 1267-201

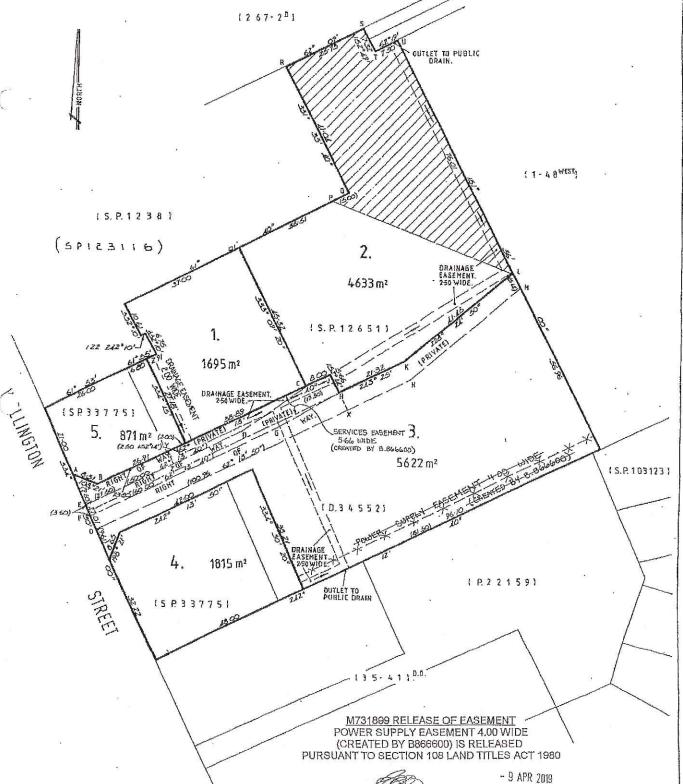

30/07/19 revised 09/08/19 DFOR GARAGE

RESIDENTIAL ZONE MIDLANDS COUNCIL BUILDING AREAS

BUILDING SIZE 91.54 SQM

BUILDING DESIGNER:
ACCREDITATION NO:
LAND TITLE REFERENCE NUMBER:
DESIGN WIND SPEED:
SOIL CLASSIFICATION:
CLIMATE ZONE:
ALTERE APPRONE BAL RATING:

SPERSIVE SOILS: LINE SOILS: ND DUNES: NE AREA: RROSION ENVIRONMENT: DODING:

MINE A ISSIDENCE:
LAUGHLE
LAUGHLE
LAUGHLE
LAUGHLE
LAUGHLE
LAUGHLE
LAUGHLE
LAUGHLE
GROUPD LEUGHLE

UNKNOWN
UNKNOWN
REFER DWGS
REFER DWGS
REFER DWGS
MIN 150MM BELOW LOWEST
FIXTURE JO WOODBURY CC 5879 n 122410/3 refer eng refer eng UNKNOWN UNKNOWN UNKNOWN bal low NOT APPLICABLE

DOCUMENTATION BY OTHERS

Lighting Plan and Calculations by LIGHTS N LAMPS Energy Efficiency Report by TECHNISCH PL Engineer Dwgs by AMAC DRAFTING AND IPD

drawings are subject to owner discretion.

hese drawings are for permit approval purposes and additional information may be required to inform construction


contractors to verify all matters of specification, finish, selection and appearance with where prior to commencing work and ensure work carried out is acceptable to owner, notuding design variation and atternatives.

drawings used for construction must carry building surveyor certification. Ensure there is only one version of construction dwgs being used.







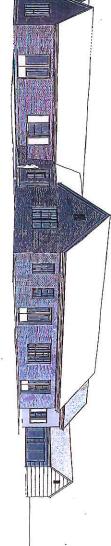

Elhibited

97 WELLINGTON STREET, LONGFORD TAS 7301 **NEW GARAGE - DANTOINE**

DRAWING SHEETS

202	S04	S03	S02	S01	Sheet	
	SHADOW DIAGRAMS	SHED PLAN	SITE PLAN	TITLE SHEET	eet Drawing	



WOODBURY&CO
BUILDING DESIGN
Phase 0407/319/437
28 Denican Fload West Luminessian TAS 7250
jo@buildingdesignstudio.com.au

Client Job Title

NEW DWELLING/GARAGE+ SHED

Drawn By: Date:

Sheet No: Project No:

> S02 SITE PLAN

AUG 2019

Drawing Title

N+V DANTOINE


97 WELLINGTON STREET LONGFORD TAS


Scale: Acreditation No.


CC 5879N Jo Woodbury

FD2018



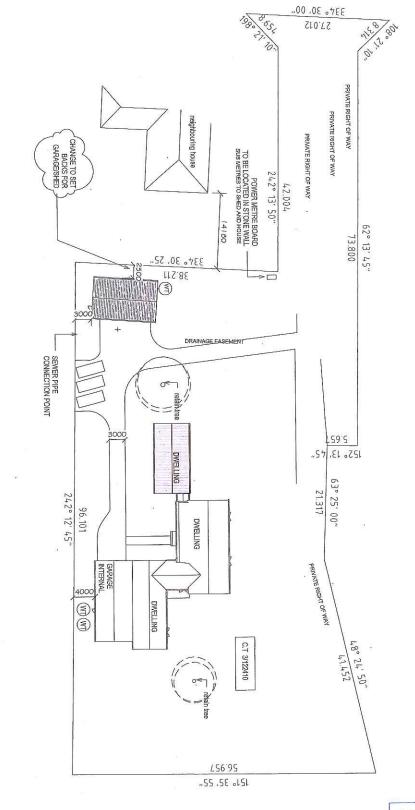


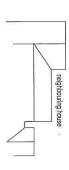

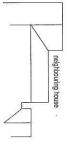






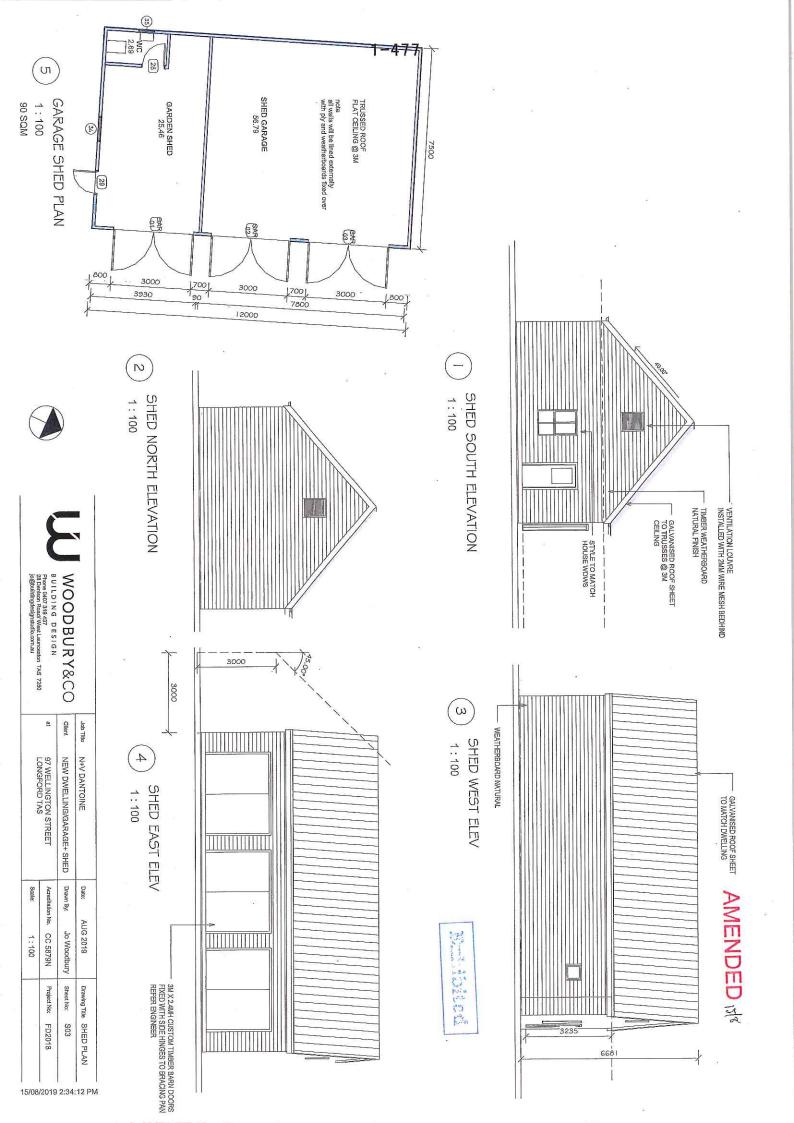


SITE PLAN SHADOWS 9AM 21 JUNE 1:1000

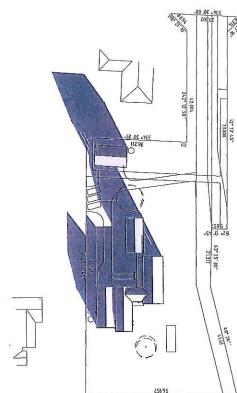

N

SITE PLAN SHADOWS 12PM 21 JUNE

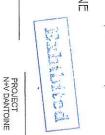

다 63* 25' 00" 양 다 63* 25' 00"

AMENDED

(W)

1:1000

SITE PLAN SHADOWS 3PM 21 JUNE

1:1000

REVISIONS Jo Woodbury WOODBURY&CO Phone 0407 319 437 28 Denison Road West Launceston TAS 7250 jo@buildingdesignstudio.com.au IICENSE No CC 5879N

SHEET NO:

FD2018

AUG 2019

1: 1000 PROJECT NO:

DRAWING TITLE SHADOW DIAGRAMS

97 WELLINGTON STREET LONGFORD TAS

LOCATION

FOR NEW DWELLING/GARAGE+ SHED

ORG (tap over) -479DP1 PLUMBING NOTES 2500 direct overflow to approved stormwater connection point TAS WATER EASEMENT 2500 M 3000 冶 무 2500 TAS WATER EASEMENT CONNECT SHED FACILITIES INTO EXISTING LOT CONNECTION PLUMBING LEGEND TITLE BOUNDARY ORG tap over DN40 vent riser through wall lundish drain DN100 TO APPROVED SEWER CONNECTION POINT Install inspection opening on WC connections Inspection opening to be provided at max 30m intervals along sewer line 밁 DP1 RH1 H 18 S PP DN 100 to approved stormwater connection point 門門 - A BA hwc refer owners specification · · -Z BA ب چ 60 RH1 through 1 DN40 ve

Install inspection openings at major bends for stormwater and all tow points of downpipes.

All plumbing & drainage to be in accordance with local Council requirements.

Provide surface drainage to back of bulk excavation to drain levelled pad prior to commencing fooling excavation.

The heated water system must be designed and installed with Part B2 of NCC Volume Three - Plumbing Code of Australia.

Sewer line (100mm UPVC)

Stormwater line (100mm UPVC)

Wet areas shown hatched.

Refer to drawing A20 for waterproofing details.

Piping located outside the building or in an unenclosed building sub-floor or roof space a) All flow and return piping b) Cold waters supply piping and Relief valve piping—within 500mm of the connection to central water heating system Must have a minimum R-Value of 0.6 (a 25mm of closed cell polymer insulation)

Piping within an insutated timber framed wall, such as that bassing through a wall stud, is considered to comply with the

dwm s

400 basin 500 shower 400 bath 500 sink 400 dish washing machine 500 trough 400 washing machine 1000 water doset educt vent overflow relief gully

Thermal insulation for healed water piping must:
a) be protected against the effects of weather and sunlight; and b)
be able to withstand the temperatures within the piping; and
c) use thermal insulation in accordance with ASINZS 4859.1

rod eye înspection opening

Heated water piping that is not within a conditioned space must be thermally insulated as follows: I ultimat piping a) All flow and return internal piping that is ...) within an unventilated wat space it) within an internal floor between storeys; or it) between ceiling insulation and a ceiling must have a minimum R-Value of 0.2 (le gram of closed cell polymer insulation)

2. Piping located within a verifilated wall space, an enclosed building suthoro or a roof space a) All flow and return piping b) Cold water supply piping and Relief valve piping-within 500mm of the connection to central water healing system must have a minimum R-Value of 0.45 (le 18mm of closed cell polymer insulations).

line refer owner for external tap locations

Install inspection opening on WC connections
Inspection opening to be provided at max 30m intervals along sewer

For internal hot water storage provide galvanised tray under storage cylinder with overflow piped to outside of building or connected to

B U I L D | N G DES | G N
Phone 0407 319 437
28 Denison Road/ West Launceston TAS 7250
[o@bulldingdesignstudin.com.au WOODBURY&CO

8 Cllent Job Tille 97 WELLINGTON STREET LONGFORD TAS N+V DANTOINE NEW DWELLING/GARAGE+ SHED Drawn By: Date: Acreditation No. AUG 2019 CC 5879N Jo Woodbury 1:200 Sheet No: Drawing Tille Project No: FD2018 S05 DRAINAGE PLAN

9/08/2019 12:40:32 PM

NORTHERN MIDLANDS COUNCIL

REPORT FROM:

HERITAGE ADVISER, DAVID DENMAN

DATE:

19 August 2019

REF NO:

PLN-19-0154; 113600.383

SITE:

97 Wellington Street, Longford

PROPOSAL:

Garage (12m x 7.5m, apex 6.6m)(vary internal front setback

to 2.5m; Heritage Precinct)

APPLICANT:

Wis Jo Woodbury

REASON FOR REFERRAL:

HERITAGE PRECINCT

HERITAGE-LISTED PLACE

Local Historic Heritage Code

Heritage Precincts Specific Area Plan

Do you have any objections to the proposal:

No

Do you have any other comments on this application?

The new garage will not be visible from the street.

Email referral as word document to David Denman – <u>david@denman.studio</u> Attach public exhibition documents

Subject line: Heritage referral PLN-19-0154 - 97 Wellington Street, Longford

David Denman (Heritage Adviser)

Date: 3/9/2019



Submission to Planning Authority Notice

PLN-19-0154			Council notice	10/00/2010
	PLN-19-0154		date	19/08/2019
TWDA 2019/01209	2019/01209-NMC		Date of response	27/08/2019
100772013701203	.013/01203 NWC			
Sam Bryant Phone No.		(03) 6237 8642		
Sam Bryant Phone No				
0				
NORTHERN MIDLANDS COUNCIL				
Planning@nmc.tas.gov.au			0	
ails				
97 WELLINGTON ST, LONGFORD		Property ID (PID)	1824212	
Garage				
ngs/documents				
red by	Drawing/document No.		Revision No.	Date of Issue
uilding Design	Drainage plan			Aug 2019
	Sam Bryant NORTHERN MIDLA Planning@nmc.tas iils 97 WELLINGTON S Garage ngs/documents ed by	NORTHERN MIDLANDS COUNCIL Planning@nmc.tas.gov.au iils 97 WELLINGTON ST, LONGFORD Garage ngs/documents ed by Drawing/doc	Sam Bryant Phone No. NORTHERN MIDLANDS COUNCIL Planning@nmc.tas.gov.au sils 97 WELLINGTON ST, LONGFORD Garage ngs/documents ed by Drawing/document No.	Sam Bryant Phone No. (03) 6237 8642 NORTHERN MIDLANDS COUNCIL Planning@nmc.tas.gov.au sils 97 WELLINGTON ST, LONGFORD Property ID (PID) Garage ngs/documents ed by Drawing/document No. Revision No.

Conditions

Pursuant to the *Water and Sewerage Industry Act* 2008 (TAS) Section 56P(1) TasWater imposes the following conditions on the permit for this application:

56W CONSENT

1. Prior to the issue of the Certificate for Certifiable Work (Building) and/or (Plumbing) by TasWater the applicant or landowner as the case may be must make application to TasWater pursuant to section 56W of the Water and Sewerage Industry Act 2008 for its consent in respect of that part of the development which is built within two metres of TasWater infrastructure.

The plans submitted with the application for the Certificate for Certifiable Work (Building) and/or (Plumbing) must show footings of proposed buildings located over or within 2.0m from TasWater pipes and must be designed by a suitably qualified person to adequately protect the integrity of TasWater's infrastructure, and to TasWater's satisfaction, be in accordance with AS3500 Part 2.2 Section 3.8 to ensure that no loads are transferred to TasWater's pipes. These plans must also include a cross sectional view through the footings which clearly shows;

- a. Existing pipe depth and proposed finished surface levels over the pipe;
- b. The line of influence from the base of the footing must pass below the invert of the pipe and be clear of the pipe trench and;
- c. A note on the plan indicating how the pipe location and depth were ascertained.

DEVELOPMENT ASSESSMENT FEES

2. The applicant or landowner as the case may be, must pay a development assessment fee of \$211.63, to TasWater, as approved by the Economic Regulator and the fees will be indexed, until the date paid to TasWater.

The payment is required by the due date as noted on the statement when issued by TasWater.



Advice

General

For information on TasWater development standards, please visit

https://www.taswater.com.au/Development/Technical-Standards

For application forms please visit http://www.taswater.com.au/Development/Forms

Service Locations

Please note that the developer is responsible for arranging to locate the existing TasWater infrastructure and clearly showing it on the drawings. Existing TasWater infrastructure may be located by a surveyor and/or a private contractor engaged at the developers cost to locate the infrastructure.

The location of infrastructure as shown on the GIS is indicative only.

- A permit is required to work within TasWater's easements or in the vicinity of its infrastructure. Further information can be obtained from TasWater
- TasWater has listed a number of service providers who can provide asset detection and location services should you require it. Visit www.taswater.com.au/Development/Service-location for a list of companies
- TasWater will locate residential water stop taps free of charge
- Sewer drainage plans or Inspection Openings (IO) for residential properties are available from your local council.

Services crossing easements

Private underground pipework crossing the easement must maintain adequate clearance between existing TasWater sewerage infrastructure and private underground services in accordance with WSA 02-2014-3.1. Table 5.4 Private services may cross an easement but not be run parallel to existing infrastructure within the easement.

Declaration

The drawings/documents and conditions stated above constitute TasWater's Submission to Planning Authority Notice.

Authorised by

Jason Taylor

Development Assessment Manager

TasWater Contact Details				
Email	development@taswater.com.au	Web	www.taswater.com.au	
Mail	GPO Box 1393 Hobart TAS 7001			



The General Manager Northern Midlands Council PO Box 156 Longford Tasmania 7301 21st August '19

Dear Sir/Madam

I write in relation to Development Application Reference No: PLN-19-0154 Site: 97 Wellington Street, Longford

As a potential purchaser of 99 Wellington Street with an accepted contract in place I wish to lodge the following concerns in relation to the shed design on our eastern boundary.

- The proposed shed has been moved from the Council's agreed 4mtrs from the eastern boundary of 99 Wellington Street to 2.5 mtrs with construction of foundations already well underway.
- Visual Intrusion resulting in the loss of a significant percentage of view across to Ben Lomond and surrounding mountains, the only part that 99 Wellington Street has a view beyond the garden itself. This would detract from our enjoyment of the property and one of the key reasons we wish to buy it.
- Shadowing. A shadowing forecast has been completed clearly showing a shadow at sunrise effecting the main bedroom of the house which will mean the bathroom and bedroom will be colder and darker for longer in the winter months.
 It also clearly shows that the vegetable gardens we plan to use as part of self sufficiency will be robbed of the needed winter sunlight in this area until well after 9am reducing the amount of growing time each day.
- Personal Enjoyment will be heavily reduced due to the effect of a large structure being built with the effect of 'closing us in' and reducing the sense of openness in that part of the garden.
- With the above negative effects, it will certainly devalue 99 Wellington Street when we come to resell in the future.

We would however be prepared to consider the following adjustments.

- Reduce the height and length of the shed in it's proposed position resulting in a greater view from 99 Wellington street and resulting in less shadow effect.
- Rotate the building by 90 degrees so that it backs onto their southern boundary that will considerably reduce negative effects on 99 Wellington St
- Move the shed to the eastern boundary of 97 Wellington Street so that there is no adverse impact on anyone.

We are happy to consider any other suggestions put forward that may resolve these concerns.

Kind regards

Peter and Anna Welch

20th August, 2019.

To: The General Manager, Planning Dept, Northern Midlands Council, Longford.

Location				
File No.	******			
Property				
Attachme	ente	SACIOL S		
REC'D	/ / 1405-1-170 -1	AUU, 2	.019	
GM	in the	A MYR	-	-A
DODEA !		ICRS		丁二
L.CITIMI I		IPLAN	1	
CSM	-	The state of the s		
CSM E&DM	_	BLD		

Re: Application no: PLN-19-0154 @ 97 Wellington Street, Longford.

As the owners of 99 Wellington Street we are very concerned with the proposed plans of the shed which is to be situated on our western boundary.

The proposed shed is 2.5 metres from our boundary which is 2 metres short of the 4.5 metre requirement on a average size shed but this shed is a double storey building with a proposed height of 6.6 metres which we feel is also unacceptable.

We feel that the close proximity of this will impact on our sunlight and add shade over a large proportion of our back gardens, sheds and dwelling.

Thanking you for your consideration.

Yours sincerely,

Keith & Amanda Bunn.

Happy to communicate by phone Email.

Will Send amanda's Email. B.

03/09/2019

Response to representations

97 WELLINGTON STREET, LONGFORD

Planning Application PLN-19-0154 - Garage (12m x 7.5m, apex 6.6m)

(vary internal front setback to 2.5m; Heritage Precinct)

Jo Woodbury

Woodbury&Co

81 Elizabeth Street

LAUNCESTON 7250

email: jo@buildingdesignstudio.com.au

Please find responses to the relative objections below:

1) Visual Intrusion resulting in the loss of a significant percentage of view across to Ben Lomond and surrounding mountains, the only part that 99 Wellington Street has a view beyond the garden itself. This would detract from our enjoyment of the property and one of the key reasons we wish to buy it.

Development complies with 10.4.2.A **RESPONSE**

The proposed shed was previously approved with a 4 m setback from the western boundary and a 5.5m setback form the southern boundary. The setback to the western boundary has been reduced from 4m to 2.5m (a distance of 1.5m) which is still within the permissible building envelope under the planning scheme and complies with 10.4.2.A see figure 01


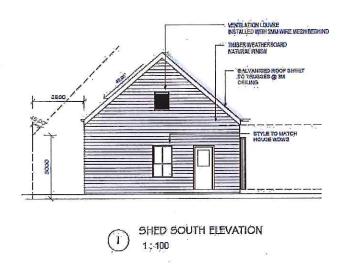


FIGURE 01

Views are not a planning directive managed by the planning scheme for residents, however, it can be demonstrated that moving the shed closer to the southern boundary has in fact created less shadowing effect on lot 99 and increased the potential for vistas afforded to 99 across the allotment of 97 - see figure 02

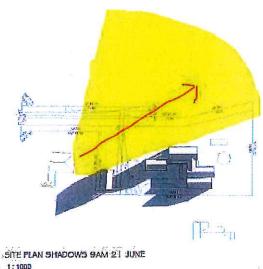


Shadowing. A shadowing forecast has been completed clearly showing a shadow at sunrise effecting the main bedroom of the house which will mean the bathroom and bedroom will be colder and darker for longer in the winter months.

It also clearly shows that the vegetable gardens we plan to use as part of self sufficiency will be robbed of the needed winter sunlight in this area until well after 9am reducing the amount of growing time each day.


- complies with 10.4.4 Sunlight and overshadowing for all dwellings RESPONSE

Shadows have been shown at 9am, 12.00noon and 3pm on 21 June – the shortest day of the year and demonstrate that the public living areas on adjoining properties are not unduly affected by loss of sunlight. There is no shadowing onto the building at all. No living areas of the neighbouring property at 99 are unduly affected by the location of or the shadows cast by the shed and Figure 03 shows the worst case scenario of the shadowing within a year and this is significantly reduced by 10am. See figure 04

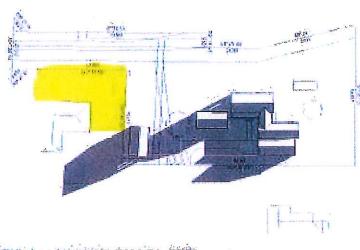

SITE PLAN SHADOWS SAM 21 JUNE 1:1000

FIGURE 03 SHADOW AT 9am

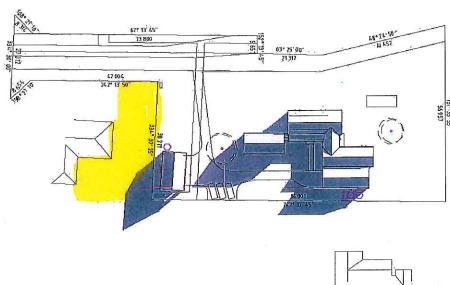

- 3) It also clearly shows that the vegetable gardens we plan to use as part of self-sufficiency will be robbed of the needed winter sunlight in this area until well after 9am reducing the amount of growing time each day.
- 4) Personal Enjoyment will be heavily reduced due to the effect of a large structure being built with the effect of 'closing us in' and reducing the sense of openness in that part of the garden.

RESPONSE

The ability to locate a garden is not governed by the planning scheme. However, the highlighted areas on FIGURES 03 AND 04 demonstrate that there is considerable space on the neighbouring allotment for a garden to receive sufficient access to sunlight and that the resident's amenity or private open space is not compromised.

The shed will be clad in natural hard wood timber boards that will naturally grey off and sit well in the landscape. The roof is a gable roof that slopes away from the neighbour's boundary and the apex height is actually 5m from the boundary – see figure 01 and 02

SUMMARY

The shed demonstrates compliance with the relative planning scheme directives for overshadowing **(10.4.2.A)** and is within the prescribed building envelope relative to the western boundary adjoining lot 99. **(10.4.4)**

The development will not impact negatively on the occupant's ability to enjoy adequate private open space or sunlight. Architecturally, the timber clad, gable roofed building is sympathetic to the buildings in the area.

Yours sincerely

Jo Woodbury

0407 319 437